MATERIAL
FINISHES

SEAT PLANK ANODIZED

RISER PLANK MILL FINISH
FOOT PLANK MILL FINISH
CHAIN LINK GALVANIZED

BRB-0815AD

NON-ELEV. ALUM. 8 ROW x 15'-0" BLEACHER


	NA-0815DLX_CLC							
DRAWING SHEET INDEX								
1.CS	COVER SHEET							
2.TD	SEATING PLAN							
3.FP	FOUNDATION PLAN							
4.ID	FRAME IDENTIFICATION							
5.BA	BLEACHER ASSEMBLY PREP							
6.BA	BLEACHER ASSEMBLY — BRACING							
7.BA	BLEACHER ASSEMBLY SECTION VIEW							
8.AP	ANCHORING PLAN							
9.PF	PLANK & FRAMING PLAN							
10.VA	VERTICAL AISLE ASSEMBLY							
11.GR	GUARDRAIL ASSEMBLY							
12.DS	TYPICAL BLEACHER ASSEMBLY DETAILS							


DRAWING REFERENCE NUMBER:

RECOMMENDED TOOLS										
SOCKET WRENCH	POP RIVET GUN	CORDLESS DRILL								
½" DEEP WELL SOCKET	LEVEL	¾6" DRILL BIT								
%6" DEEP WELL SOCKET	RUBBER MALLET	¾6" DRILL BIT								
TAPE MEASURE	GLOVES	SAFETY GLASSES								



MODEL:	MODEL: BRB-0815AD									
DESCRIPTION:	NON-	-ELEV	/. 8	ROW	x 15'-	0"	ASSEMBLY	COVE	R SH	HEET
DRAWN BY: A	ADW	DATE:	9/1	3/22	REVISION:	0	SCALE: N.T.S.	SHEET N	UMBER:	1.CS

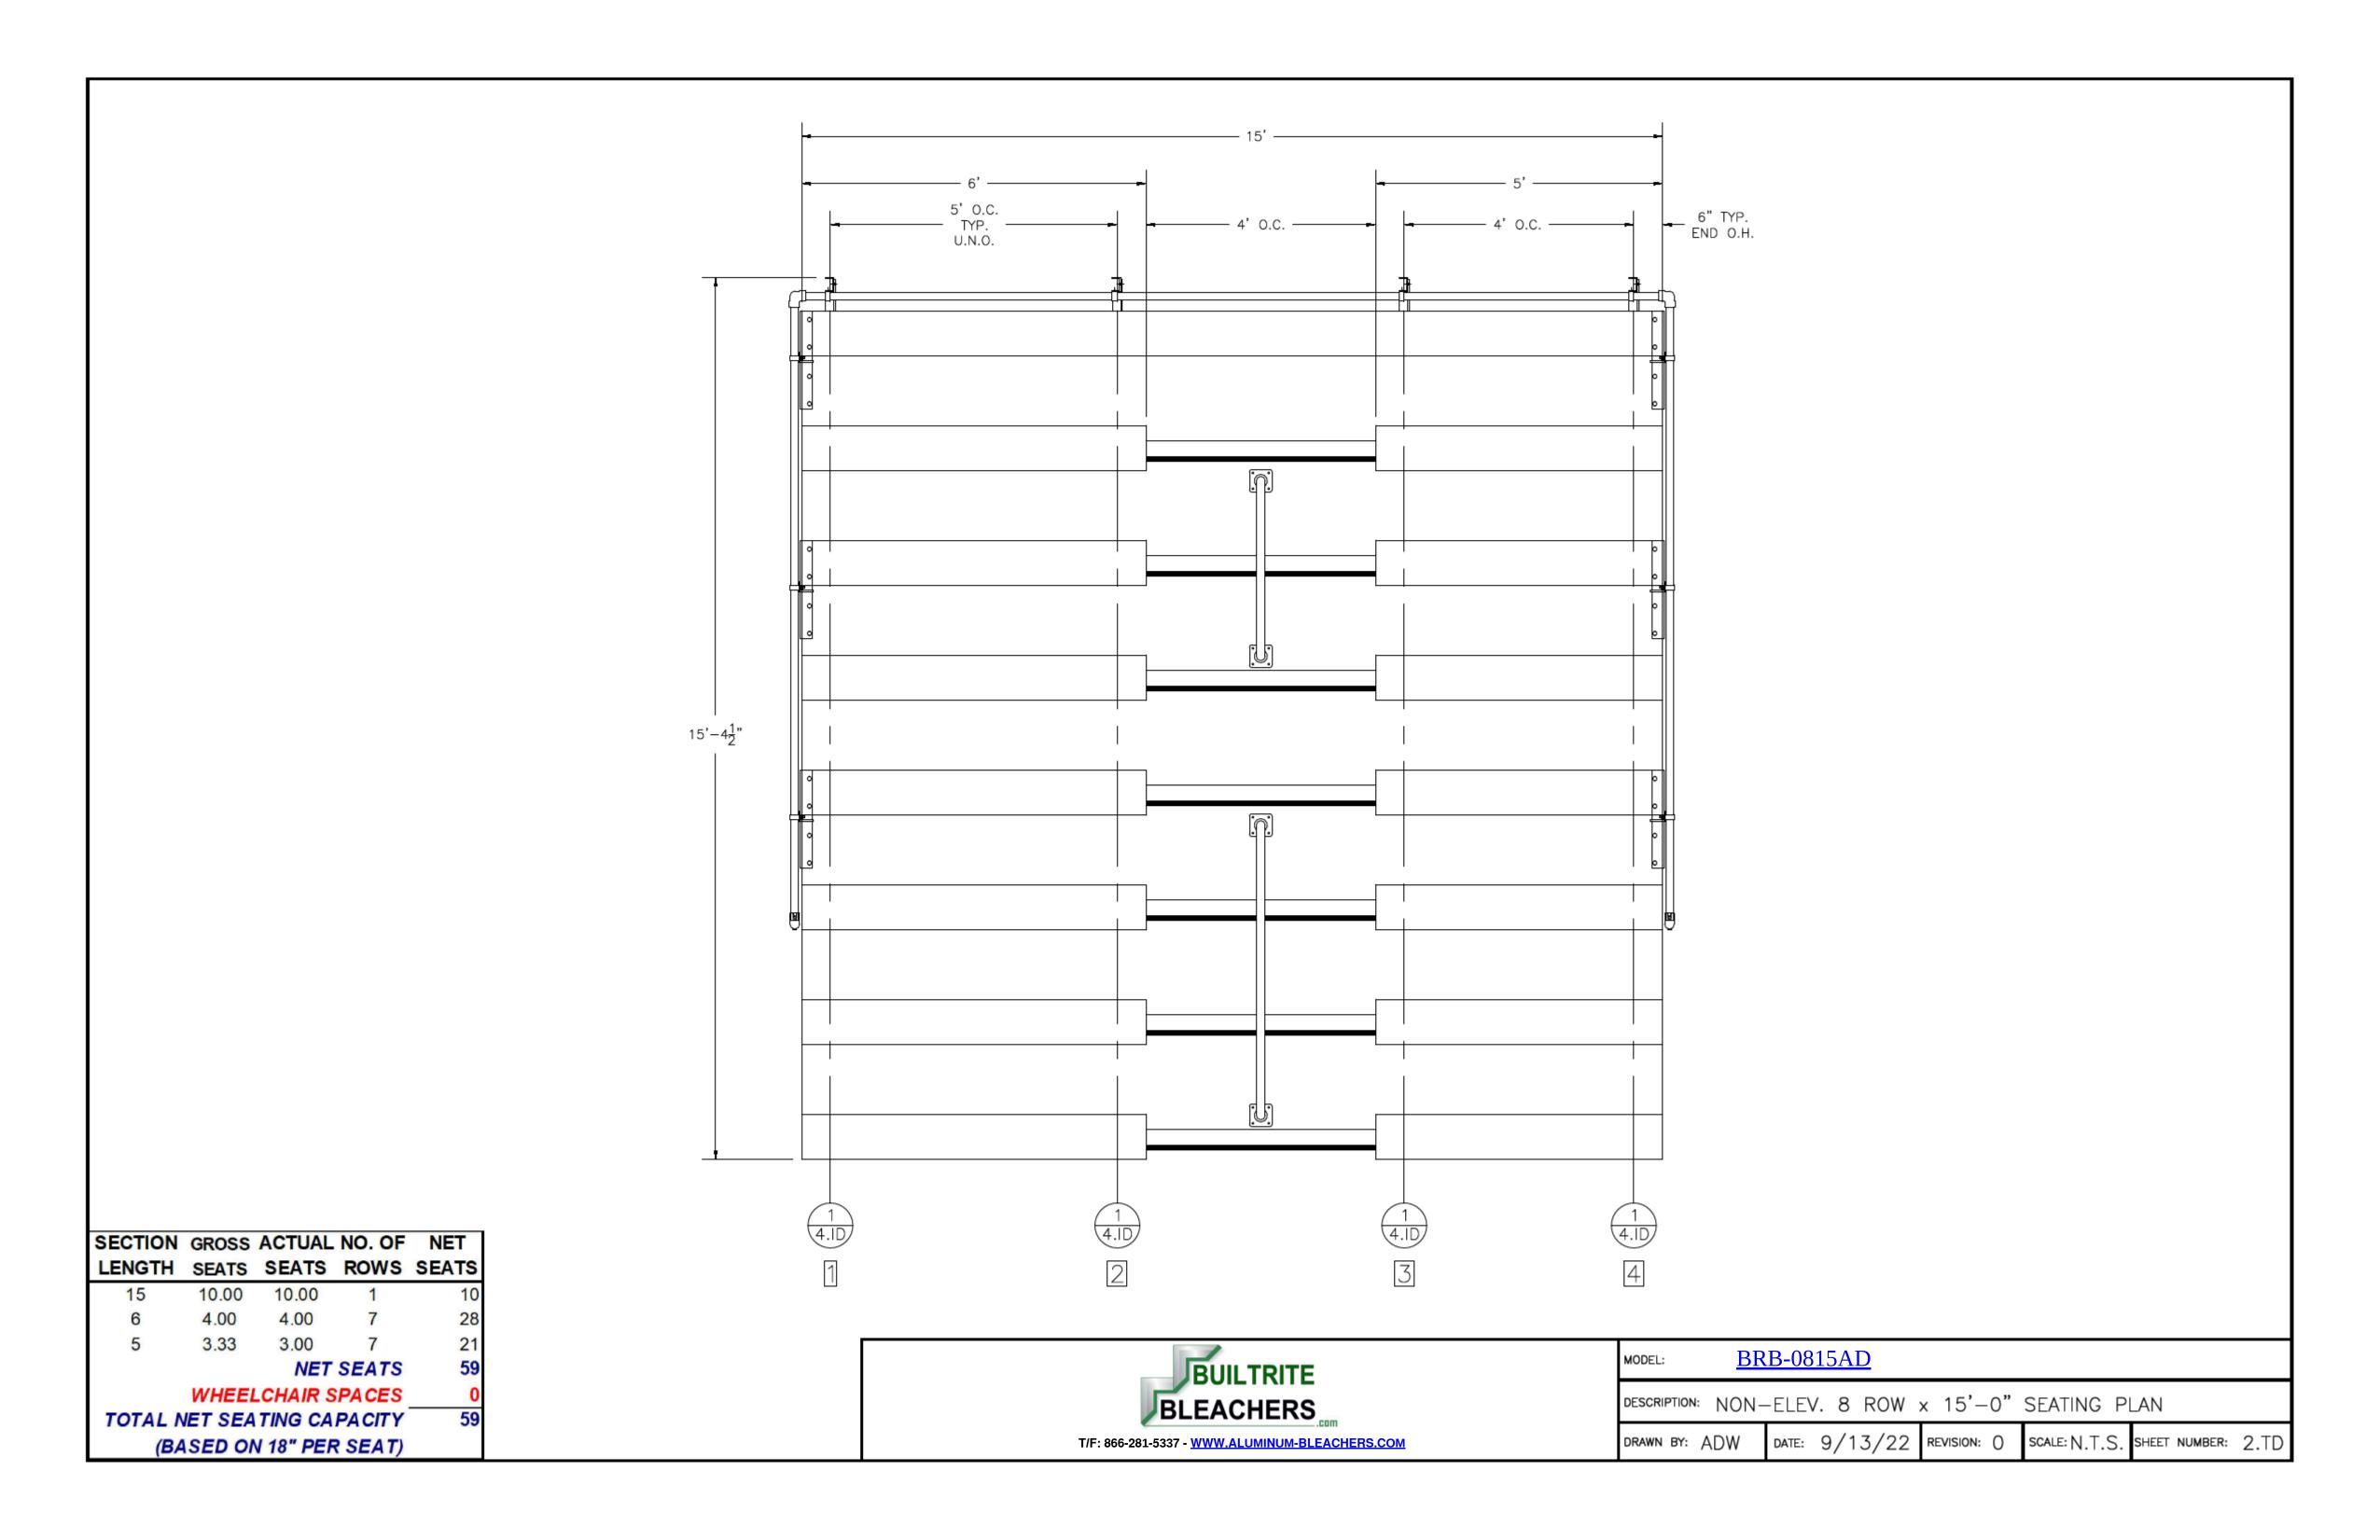

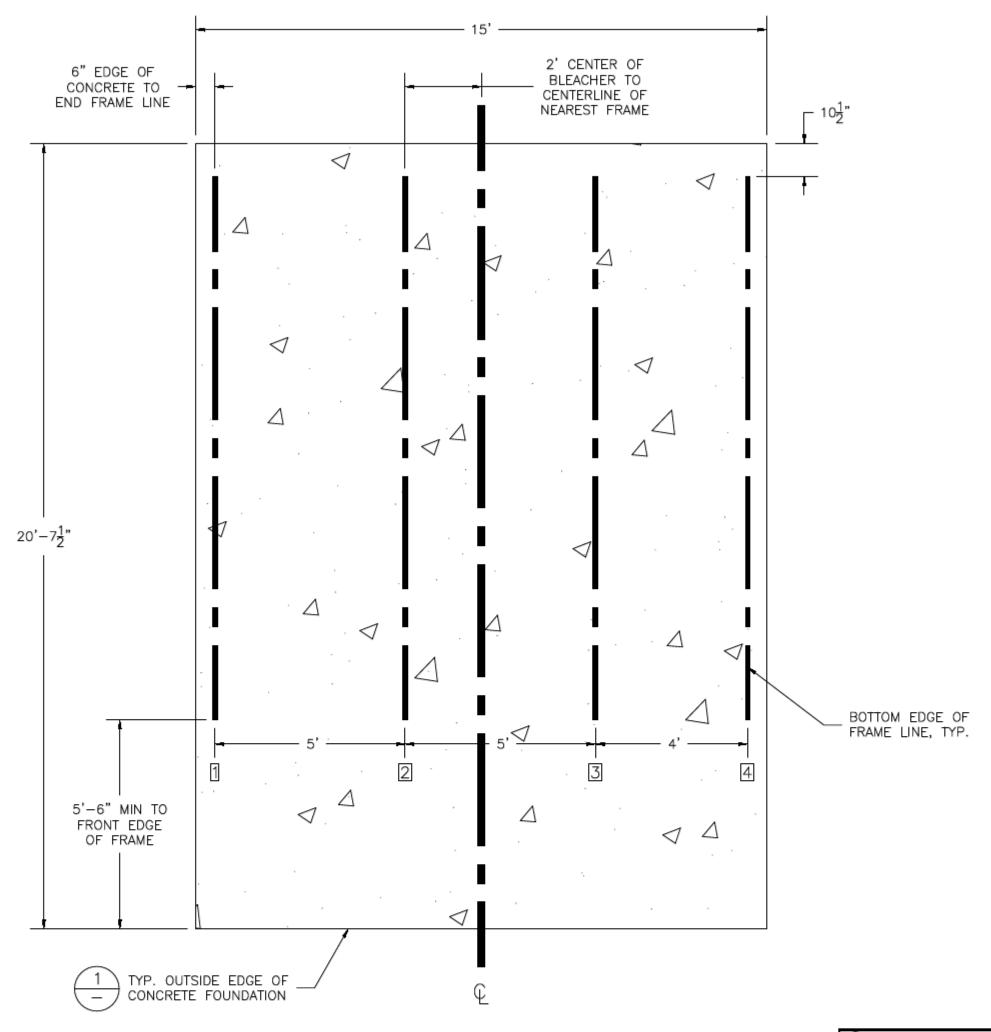

CONCRETE FOUNDATION SPECIFICATIONS

SCOPE:

Foundation construction is not part of NATIONAL RECREATION SYSTEMS, INC's., scope of work unless noted otherwise in the contract documents. The OWNER shall review the foundation design with local code authorities and coordinate with NRS, Inc.

FOUNDATION DESIGN & ANCHORS:


- 1) The foundation designs are based on the following:
 - a) Minimum presumed soil bearing of 2000 psf.
 - b) Bleacher frame dead and live load of 700 lbs./ft.
 - c) Bleacher frame wind uplift of 250 lbs./ft.
- 2) Unless otherwise specified on the drawings the bleacher frames shall be attached to concrete with a ¹²" dia. x 3³ 4" wedge type expansion anchor. The anchors shall be embedded a minimum of 2" into the concrete.

CONCRETE SPECIFICATIONS:

- 1) All concrete construction shall be in accordance with ACI 318.08.
- 2) All concrete shall be air-entrained using an air entraining admixtruing meeting *ASTM C620*. Total air content: 5%-7% per *ASTM C173*. 3) All concrete shall have a minimum 28-day strength of Fc=3000psi. Concrete shall have air-entrainment
- 4) A ¹⁴" bituminous expansion joint material shall be placed between strip and slab foundations when adjacent to each other.
- 5) The depressions in the top of the foundations between high spots shall not exceed ⁵¹⁶" below 10-foot long straightedge. The 10-foot straightedge method used to measure foundation flatness shall be in accordance with *ACI 302.1R-04* "Guide for Concrete Floor and Slab Construction".

CONCRETE SLAB RECOMMENDED SPECIFICATIONS:

- 1) Concrete slab shall have a minimum thickness of 5" (some areas may require 6") and placed on 4" of compacted gravel or compacted sub base.
- 2) NRS. INC., recommends that the concrete slab be reinforced with 6x6-W2.1xW2.1 welded wire fabric at 1¹²" concrete cover from the top. In lieu of welded wire fabric, steel fiber substitution requires OWNER approval and his understanding of potential maintenance issues.
- 3) Contractor may substitute blended fiber reinforcing, provided the blend consists of multifilament polypropylene fibers and cold drawn steel wire fibers. Novamesh 950 or approved equivalent, applied at a dosage rate of 5lb/CY unless specified otherwise or a different recommendation is made by the manufacturer.
- 4) Crack control joints shall be sawed into slab to form approximate square patterns. The maximum spacing for control joints shall not exceed 13'-6", UNLESS INDICATED OTHERWISE. The bleacher frames shall not be set on control joints. The designer shall contact NRS to coordinate joint spacing requirements with the specific bleacher design.
- 5) The slab may be sloped a maximum of 1/8 inch per foot for drainage. The maximum overall out of level slope for the slab perpendicular to the seats (front to rear) shall not exceed 2" and parallel to the seats (end to end) shall not exceed 4".

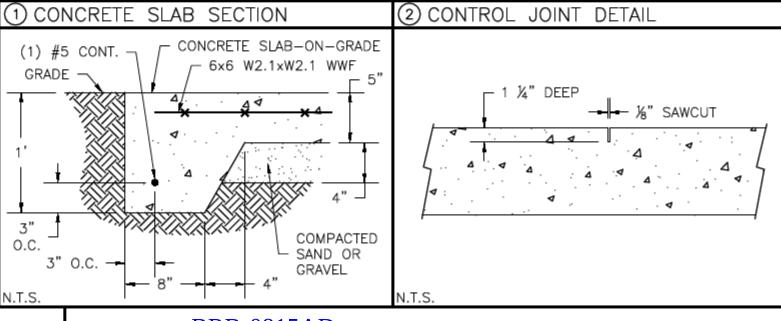




MODEL: BRB-0815AD

DESCRIPTION: NON-ELEV. 8 ROW x 15'-0" FOUNDATION PLAN

DRAWN BY: ADW DATE: 9/13/22 REVISION: 0 SCALE: N.T.S. SHEET NUMBER: 3.FP

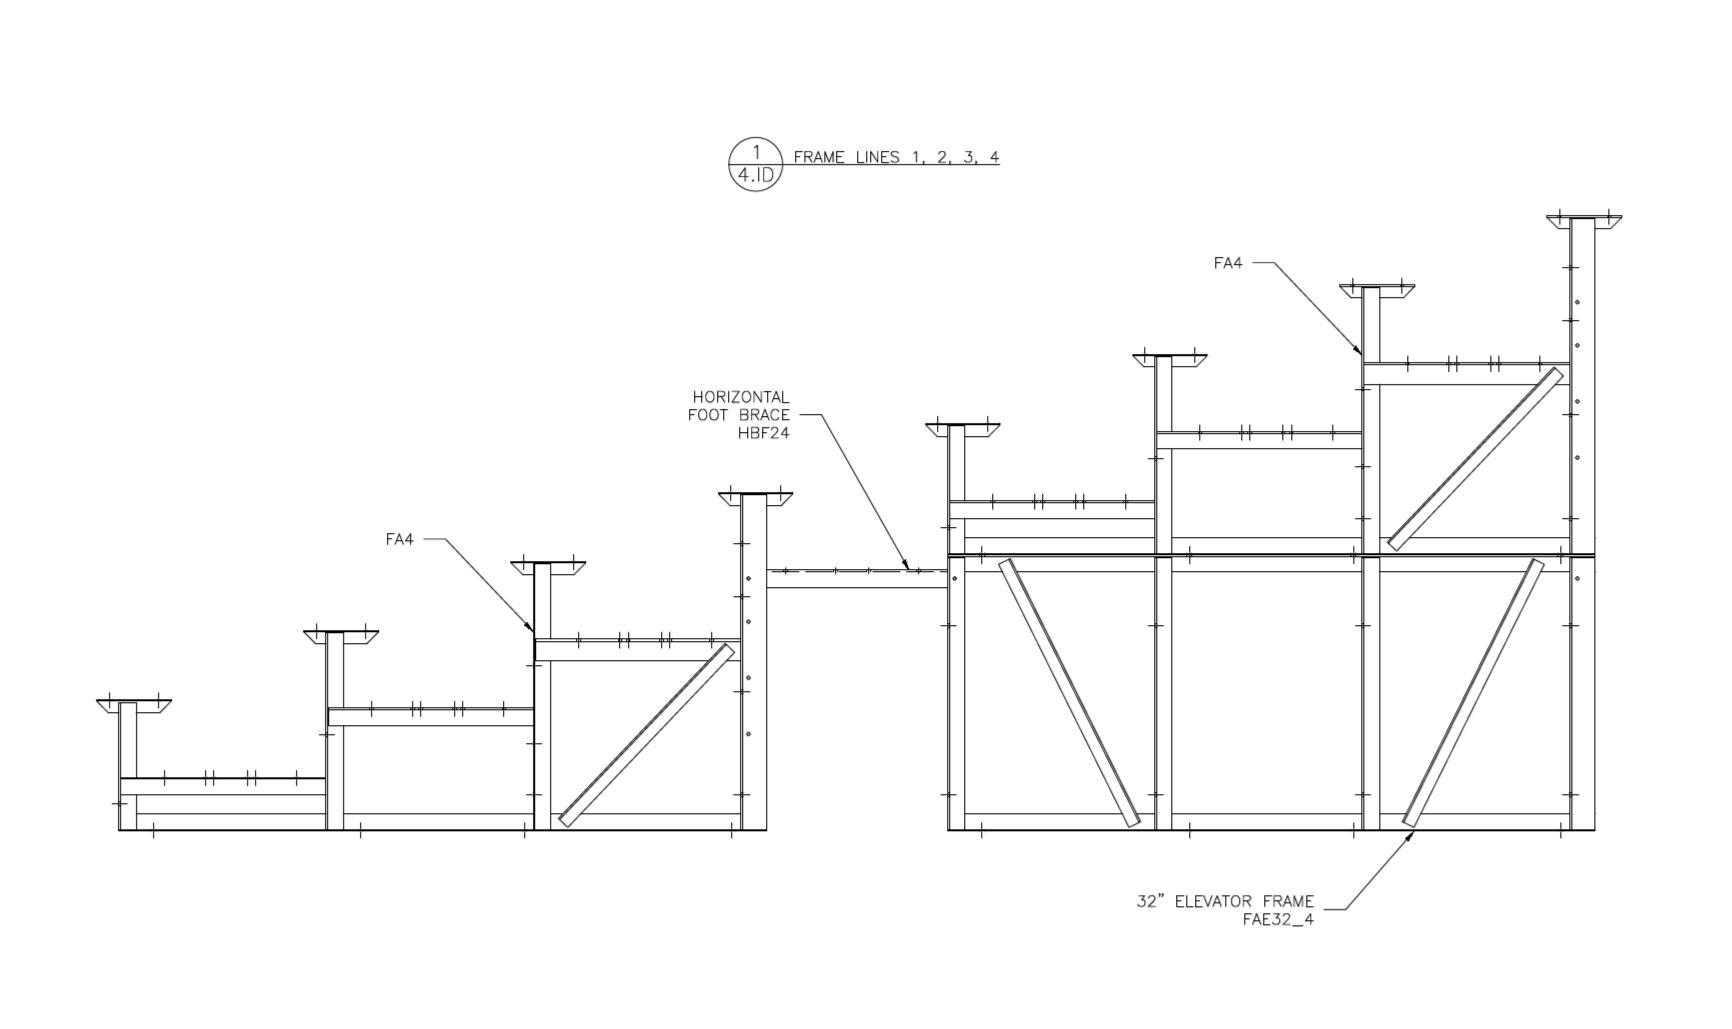



MODEL: BRB-0815AD

DESCRIPTION: NON-ELEV. 8 ROW x 15'-0" FRAME IDENTIFICATION

DRAWN BY: ADW DATE: 9/13/22 REVISION: 0 SCALE: N.T.S. SHEET NUMBER: 4.ID

